
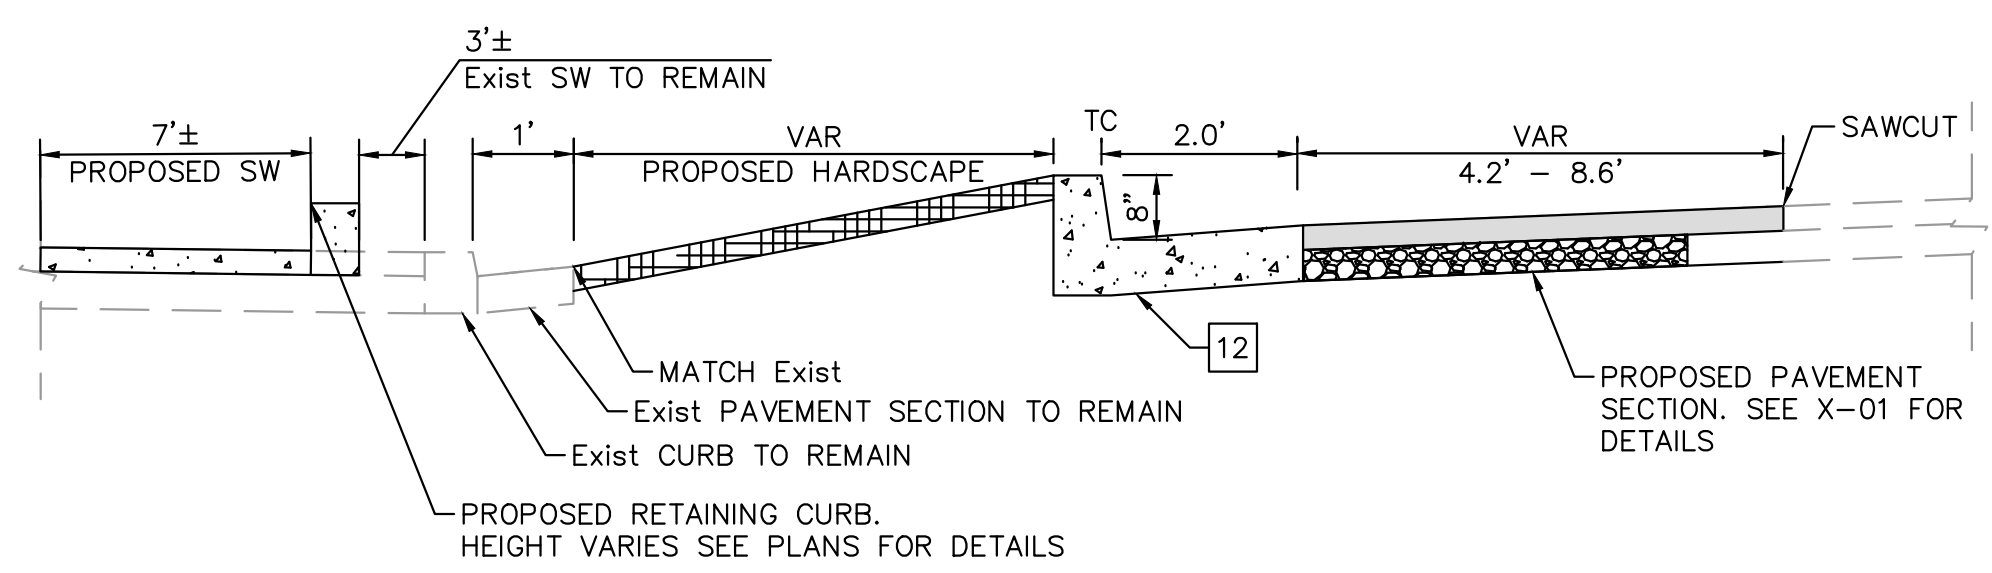


K:\BAY_RD\WY\097681004 - Stockton - Washington Corridor - DC\08 CAD\PlanSheets\05 L-01.dwg 3/25/2021 4:50 PM
 This document, together with the concepts and designs presented herein, is intended only for the specific purpose and client for which it was prepared. Reuse of any part of this document without written authorization and adaptation by Kimley-Horn and Associates, Inc., shall be without liability to Kimley-Horn and Associates, Inc.

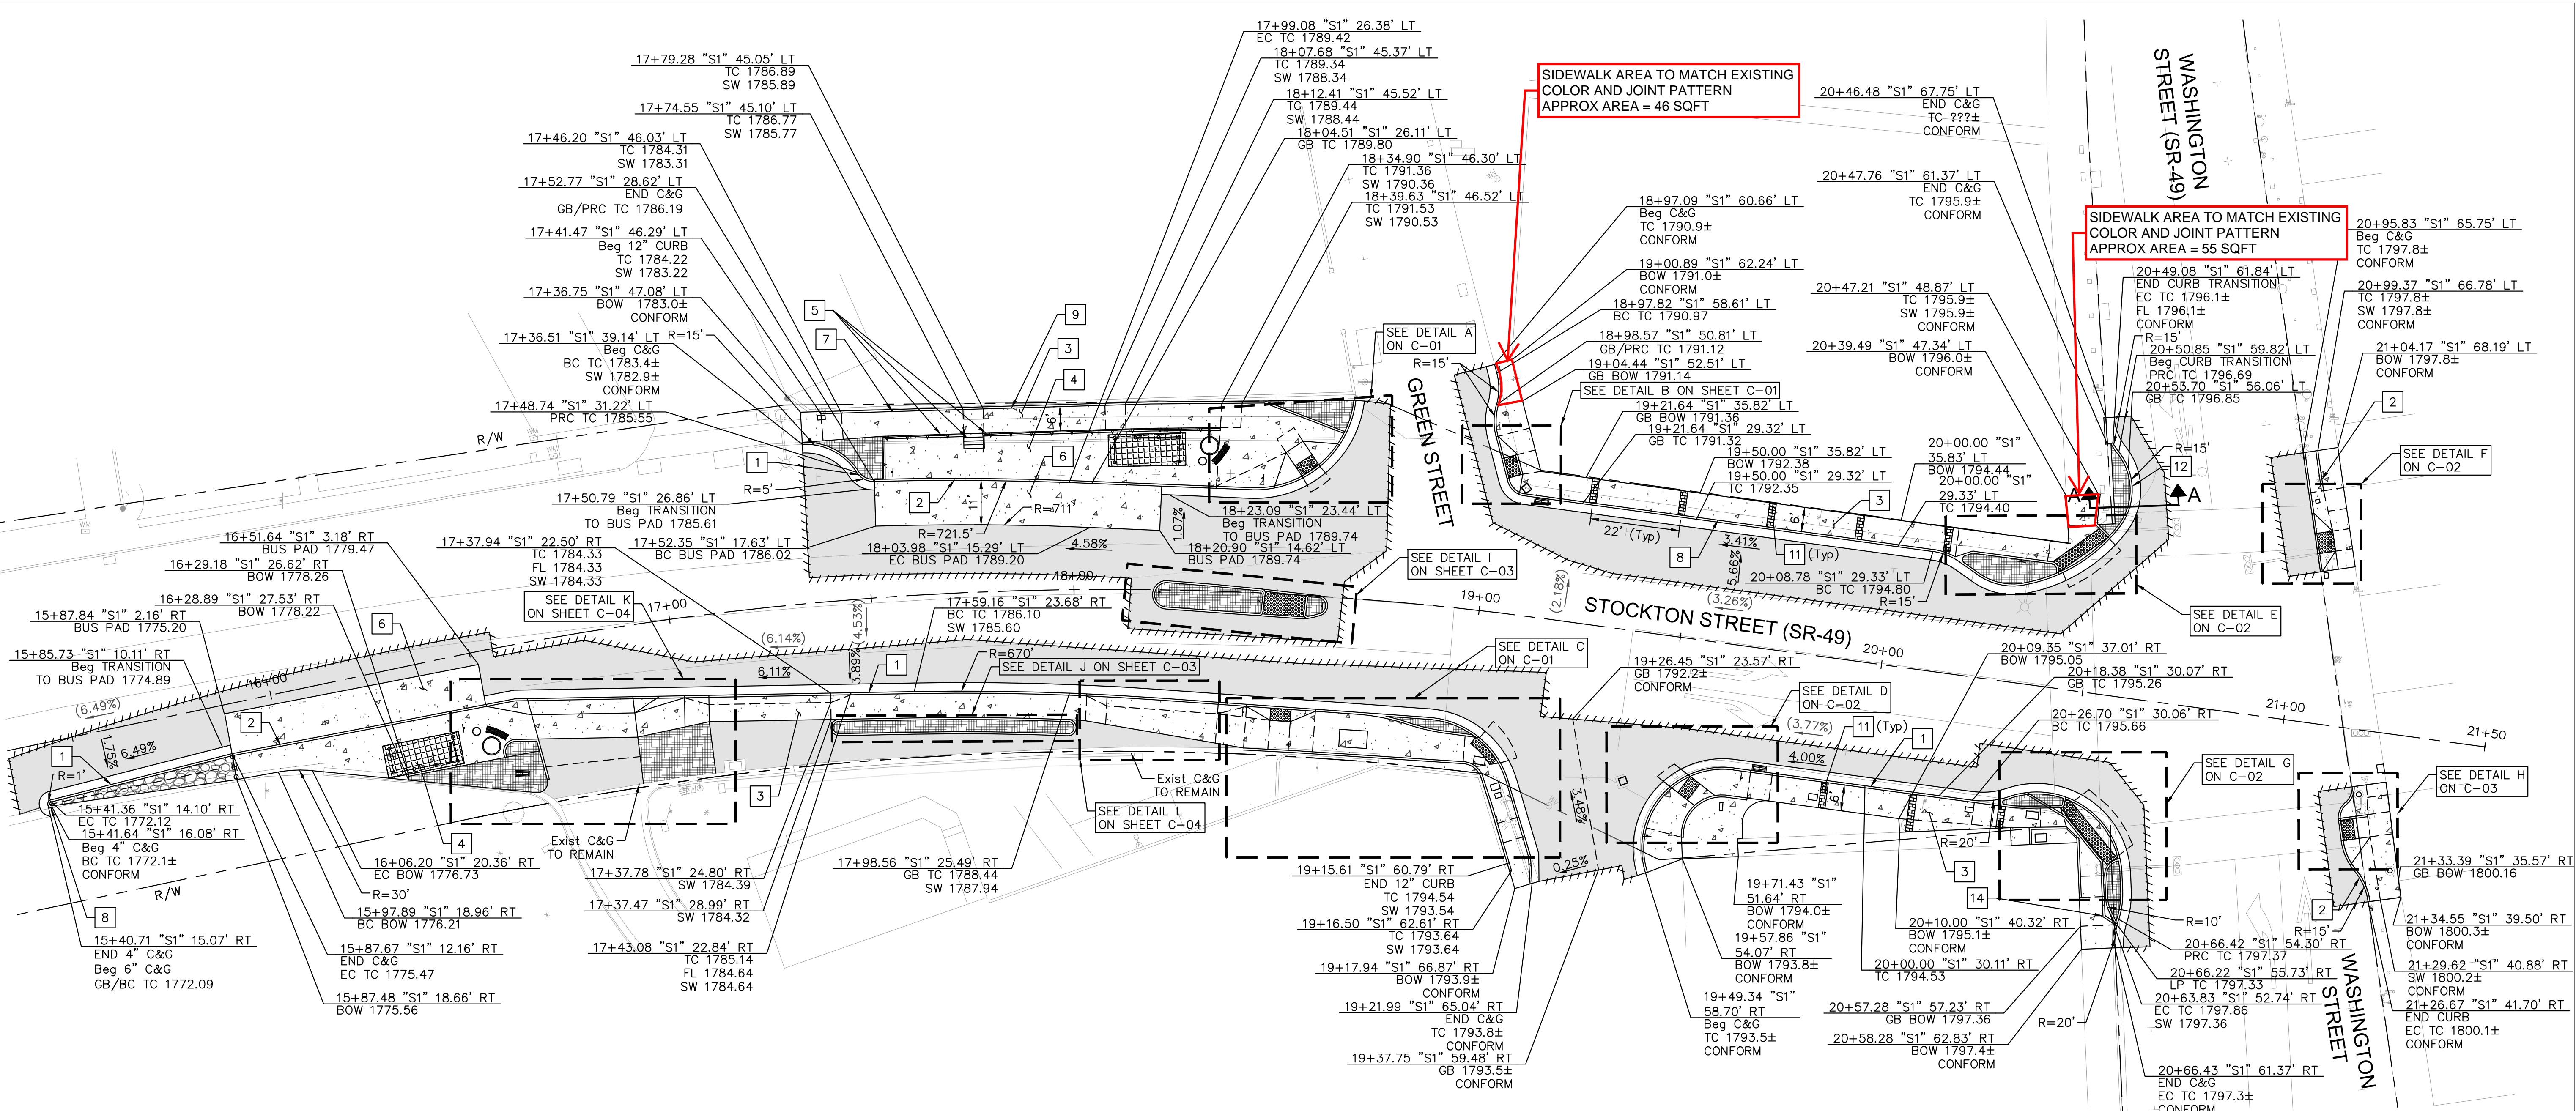

NOTES:



- RAMP TO BE CONSTRUCTED IN ACCORDANCE WITH CALTRANS STANDARD PLAN A88A, UNLESS OTHERWISE SHOWN ON PLANS.
- SIDEWALK CROSS SLOPE TO BE A MAXIMUM OF 1.5%, UNLESS OTHERWISE SHOWN ON PLANS.
- SEE UTILITY PLANS FOR DETAILS OF UTILITY FACILITIES.
- SEE DRAINAGE PLANS FOR DETAILS OF ALL DRAINAGE FACILITIES.
- SEE TRAFFIC SIGNAL PLANS FOR DETAILS OF ALL TRAFFIC SIGNAL FACILITIES.
- DETECTABLE WARNING SURFACES SHALL BE CAST IRON BY NEENAH FOUNDRY, OR APPROVED EQUAL.
- CONTRACTOR TO SUBMIT BRICK SAMPLE FOR APPROVAL BY CITY.
- CONTRACTOR TO SUBMIT WEATHERED CONCRETE SAMPLE FOR APPROVAL BY CITY.
- TRANSITION FROM CALTRANS STD CURB & GUTTER TO BUS PAD AND CURB OVER 2'.
- FOR ACCURATE RIGHT OF WAY DATA CONTACT RIGHT OF WAY ENGINEERING AT THE DISTRICT OFFICE.

CONSTRUCTION NOTES

- INSTALL TYPE A2-6 CURB AND GUTTER.
- INSTALL TYPE A1-6 CURB.
- INSTALL SIDEWALK. SEE X-01 FOR SECTION DETAILS.
- INSTALL BUS SHELTER AMENITIES. SEE UD SHEETS FOR DETAILS.
- INSTALL CONCRETE WALL, HANDRAIL, AND STAIRS. SEE RW-01 FOR DETAILS.
- INSTALL CONCRETE BUS PAD. SEE X-01 FOR SECTION DETAILS.
- RECONSTRUCT WALL DRAIN.
- INSTALL MODIFIED TYPE A2-6 CURB AND GUTTER, WITH 4" CURB HEIGHT.
- INSTALL 12" RETAINING CURB. SEE RW-01 FOR DETAILS.

- INSTALL BRICK BAND. SEE C-04 FOR DETAILS.
- INSTALL TYPE A2-8 CURB & GUTTER.
- INSTALL COMMERCIAL DRIVEWAY (CASE B) PER CALTRANS STD A87A.
- INSTALL 6" WIDE POLYCAST 600 SERIES CONCRETE TRENCH DRAIN WITH SOLID DUCTILE IRON GRATE POLYCAST D0641S, OR APPROVED EQUAL. SEE DR-01 FOR DETAILS.

LEGEND:

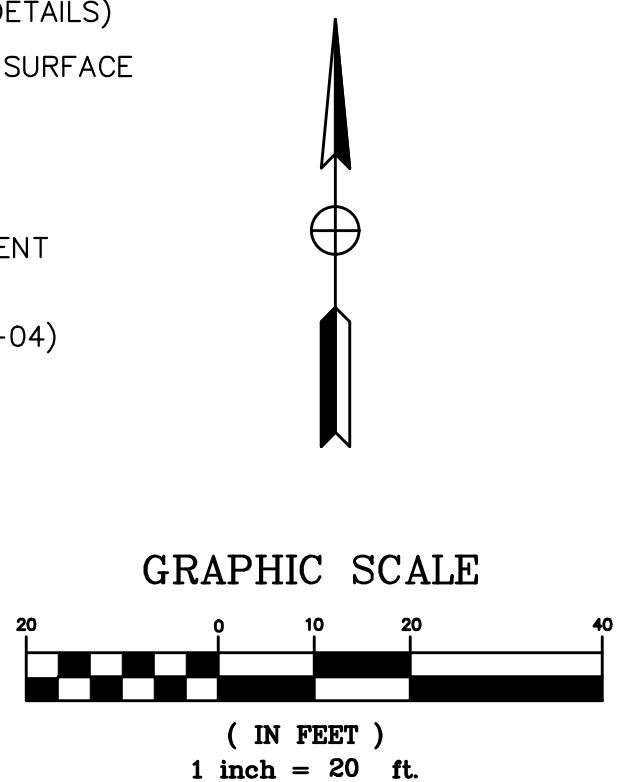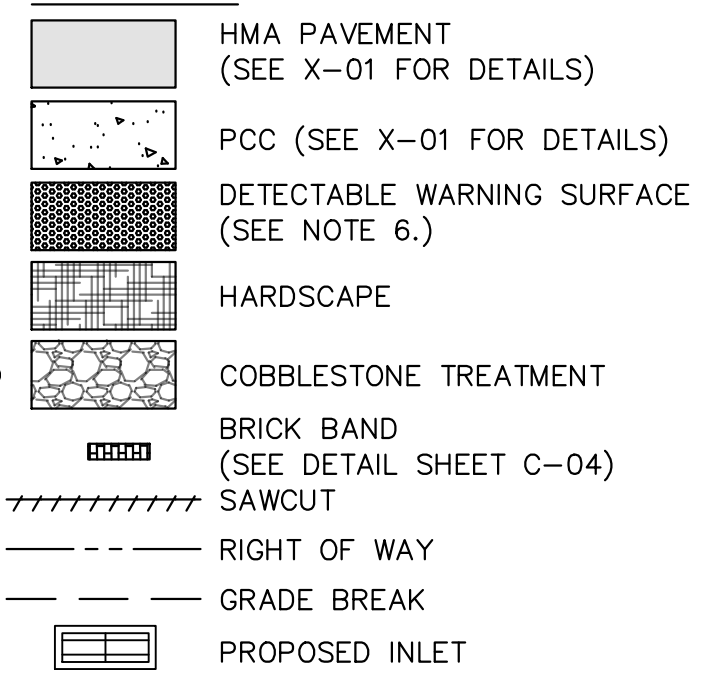

Scale AS SHOWN

Designed By: AP/DC

Drawn By: AP/DC

Checked By: DC

Consultant's Job No. 097681004

FOR REDUCED PLANS ORIGINAL SCALE IS IN INCHES

STOCKTON-WASHINGTON CORRIDOR - DOWNTOWN TRANSIT & ACCESSIBILITY PROJECT

LAYOUT PLAN

Encroachment Permit 10-1K590
 10-TUO-49 17.8/18.0

Drawing No. **L-01**
 Sheet **05** of **28**



Kimley-Horn

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